NORTHERN KENTUCKY WATER DISTRICT FORT THOMAS TREATMENT PLANT FILTER RENOVATIONS

COMMISSIONERS

FRED MACKE, JR. - CHAIR ANDREW C. COLLINS - VICE-CHAIR JOE KOESTER - SECRETARY DOUG WAGNER - TREASURER PAT SOMERKAMP - COMMISSIONER FRANK JACKSON - COMMISSIONER


RON LOVAN - PRESIDENT/CEO

CHARLES PANGBURN - ATTORNEY

FEGEVED

JUL 0 2 2009

PUBLIC SERVICE COMMISSION

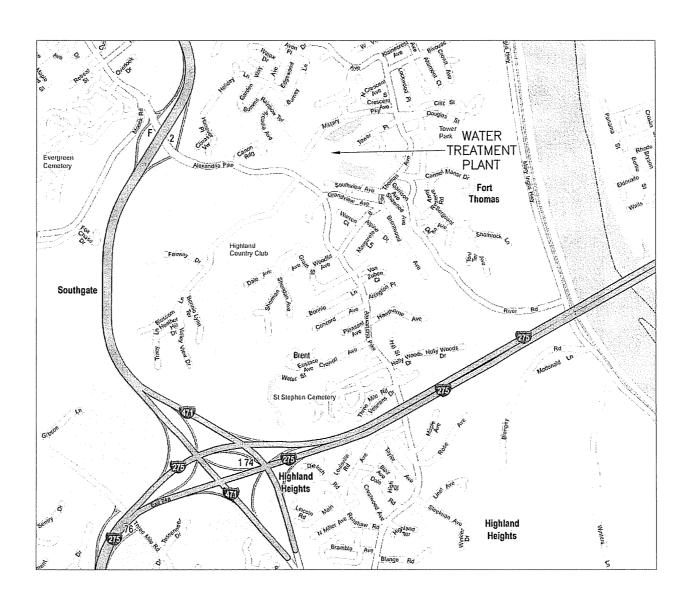

	DRAWING INDEX			
NO.	SHEET TITLE			
1	TITLE			
2	SITE PLAN			
3	CONTRACTOR STAGING LOCATION PLAN			
4	FTTP FILTER BUILDING FIRST FLOOR RENOVATION PLAN			
5	FTTP FILTER BUILDING PIPE GALLERY DEMOLITION PLAN			
6	FTTP FILTER BUILDING NORTH BASEMENT DEMOLITION PLAN			
7	FTTP FILTER BUILDING SOUTH BASEMENT DEMOLITION PLAN			
8	FTTP FILTER BUILDING DEMOLITION SECTIONS			
9	FTTP FILTER BUILDING FIRST FLOOR RENOVATION DETAILS			
10	FTTP FILTER BUILDING PIPE GALLERY AIR PIPING PLAN			
11	FTTP FILTER BUILDING NORTH BASEMENT FILTER RENOVATION PLAN			
12	FTTP FILTER BUILDING SOUTH BASEMENT RENOVATION PLAN			
13	FTTP FILTER BUILDING FILTER RENOVATION SECTIONS			
14	FTTP FILTER BUILDING FILTER BOX RENOVATION DETAILS			
15	FTTP FILTER BUILDING FILTER AIR SCOUR BLOWER DETAILS			
16	PROCESS MECHANICAL DETAILS			
17	FTTP FILTER BUILDING PIPE GALLERY ELECTRICAL DEMOLITION PLAN			
18	FTTP FILTER BUILDING PIPE GALLERY ELECTRICAL PLAN			
19	ELECTRICAL NOTES, SYMBOLS AND DETAILS			
20	ELECTRICAL DIAGRAMS CLARIFIER PLC CP-5			



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NORTHERN KENTUCKY WATER DISTRICT FORT THOMAS TREATMENT PLANT


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TITLE


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FILTER RENOVATIONS



- PROPOSED CONTRACTOR STAGING AREA. OBTAIN OWNER APPROVAL FOR SPECIFIC USE OF EACH AREA PRIOR TO PLACEMENT OF TRAILERS, PIPING RACKS, UNDERDRAIN PALLETS, AND MEDIA CONTAINERS.
- During all construction operations, insure that one lane is passable (by district pick-up trucks) along entire length of reservoir access road.

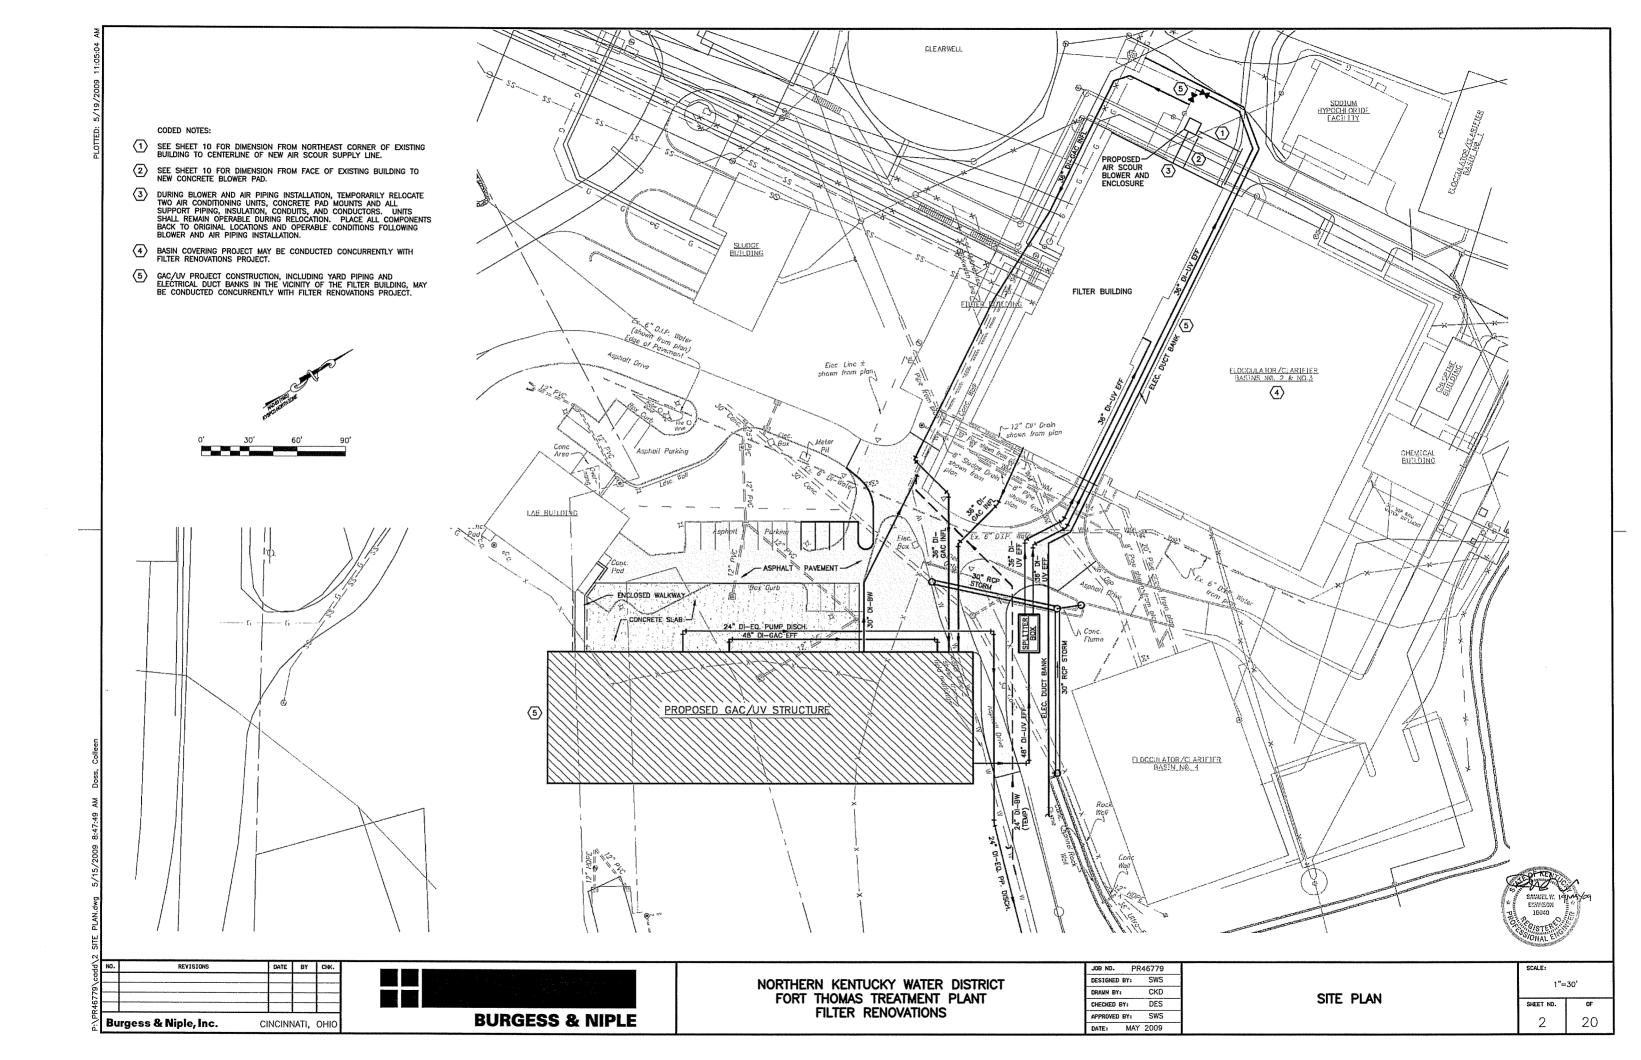

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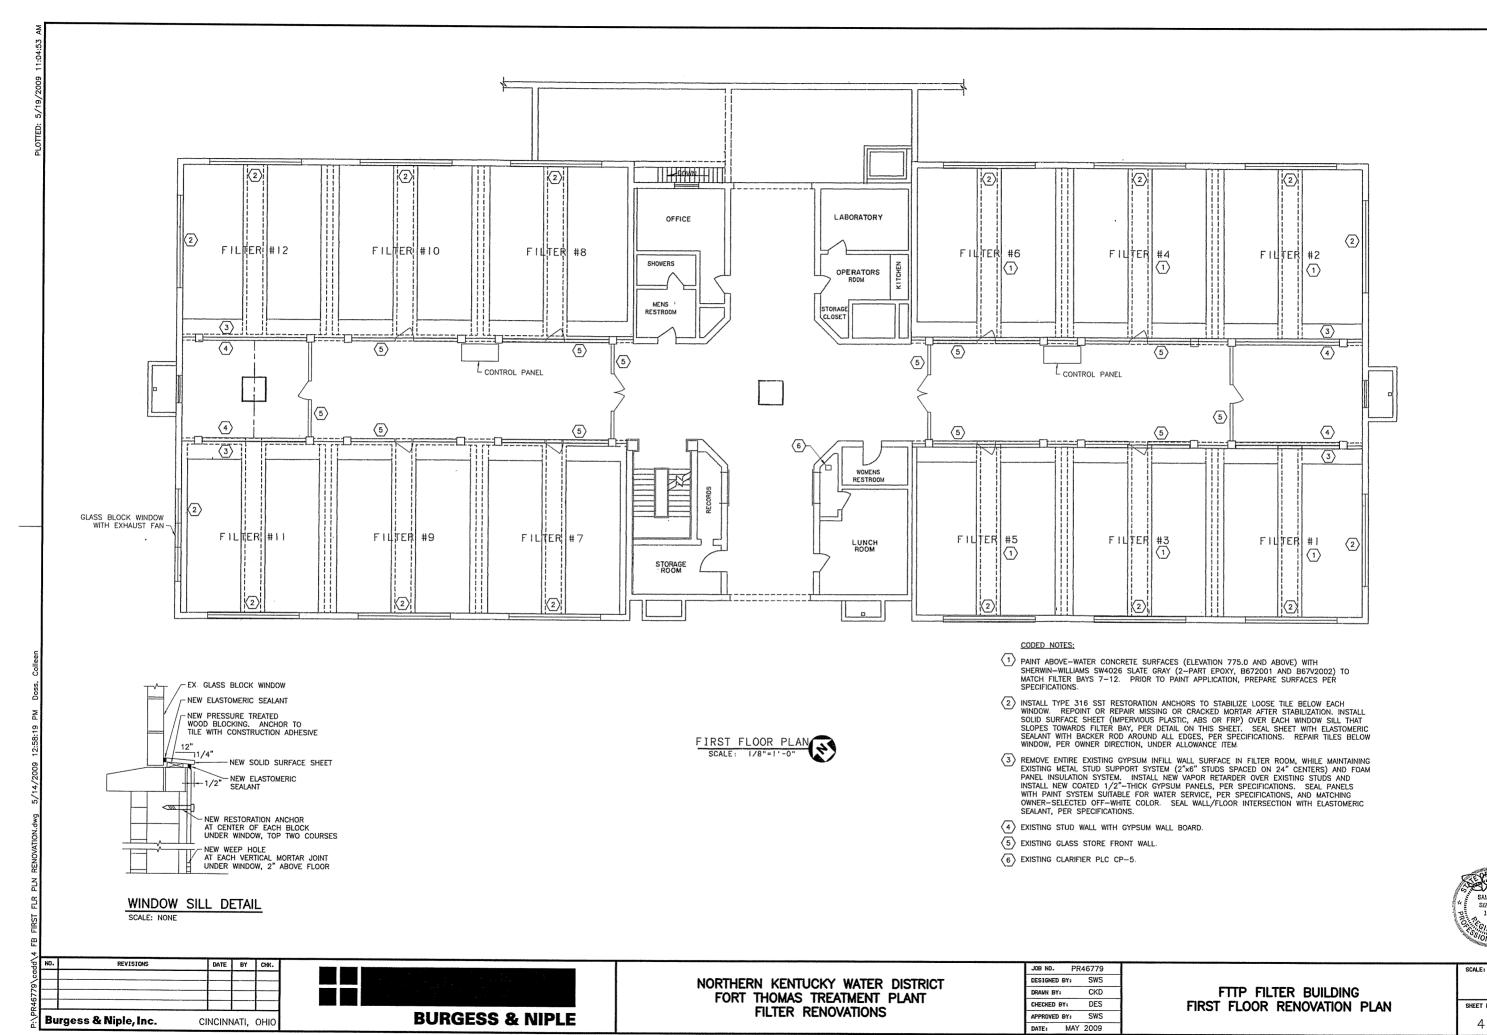
CLEARWELL

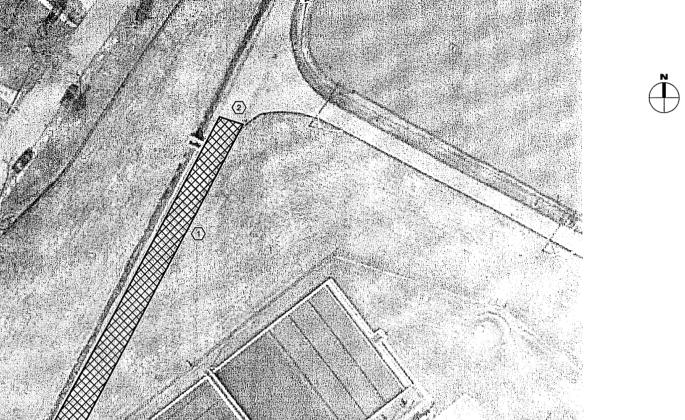NORTHER	RN KEN	TUCKY	WATER	DISTRICT
FORT	THOMA	s trea	TMENT	PLANT
	FILTER	RENO\	VATIONS	;

JOB NO. PR	46779
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CONTRACTOR	STAGING	LOCATION	PLAN
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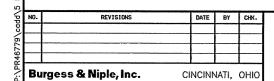
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1"=3	30'±	l
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SHEET NO. 0F 4 20

NONE

- 5) DISPOSE OF ALL REMOVED ITEMS THAT OWNER DOES NOT WANT OFF WTP SITE AT A PROPER DISPOSAL FACILITY. STOW OWNER-RETAINED ITEMS AT WTP SITE LOCATION AS INDICATED BY OWNER.
- $\fbox{6}$ Equipment and materials access to PIPE gallery limited to 42"x49" roadway hatch and 38.5" Wide Person door leading from storage room.
- PROTECT EXISTING CONTROL AND POWER CONDUITS DURING DEMOLITION OF EXISTING PIPING AND INSTALLATION OF NEW PIPING. CONDUIT POSITION ON EXISTING SUPPORTS CAN BE ADJUSTED WITH OWNER'S ASSISTANCE AND DIRECTION. EXISTING SMALL—DIAMETER GREEN—PAINTED WATER LINES MAY ALSO BE REROUTED IF NECESSARY PENDING OWNER'S DIRECTION AND APPROVAL. USE SCHEDULE 80 PVC FOR NEW WATER LINES.







NORTHERN KENTUCKY WATER DISTRICT FORT THOMAS TREATMENT PLANT FILTER RENOVATIONS

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İ	APPROVED BY:	SWS	7
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FTTP FILTER BUILDING PIPE GALLERY DEMOLITION PLAN

SCALE:	
1/8"=	=1'-0"
SHEET NO.	0F
5	20



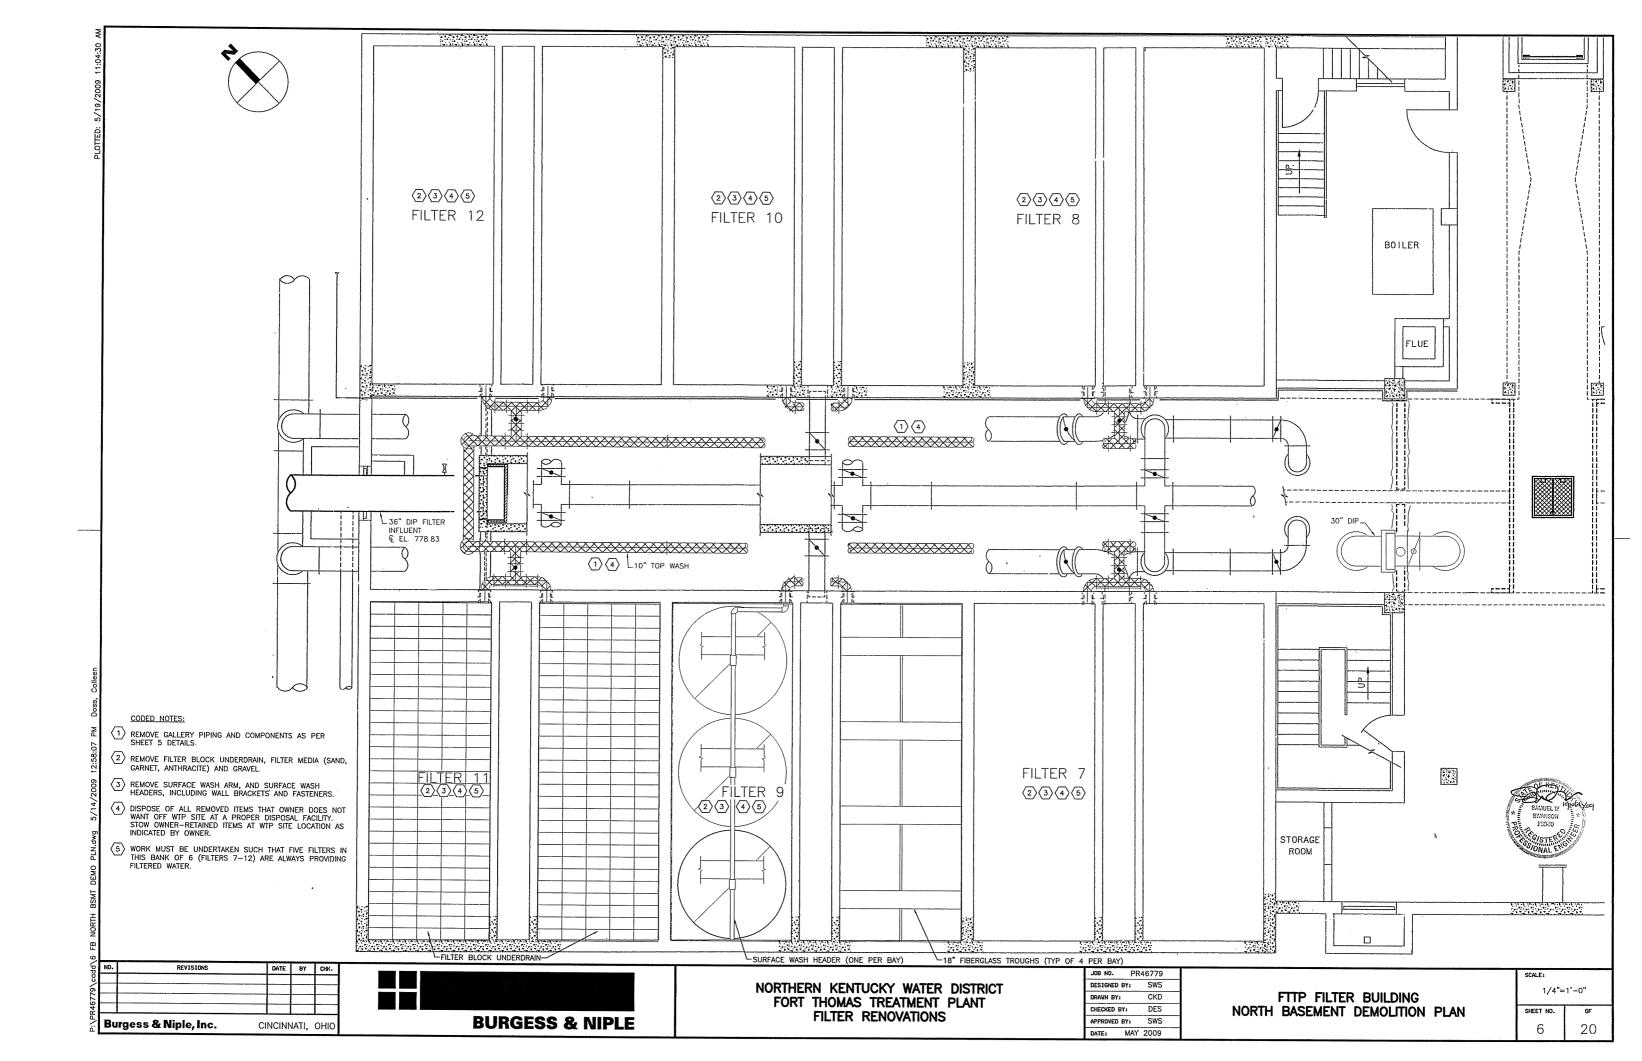
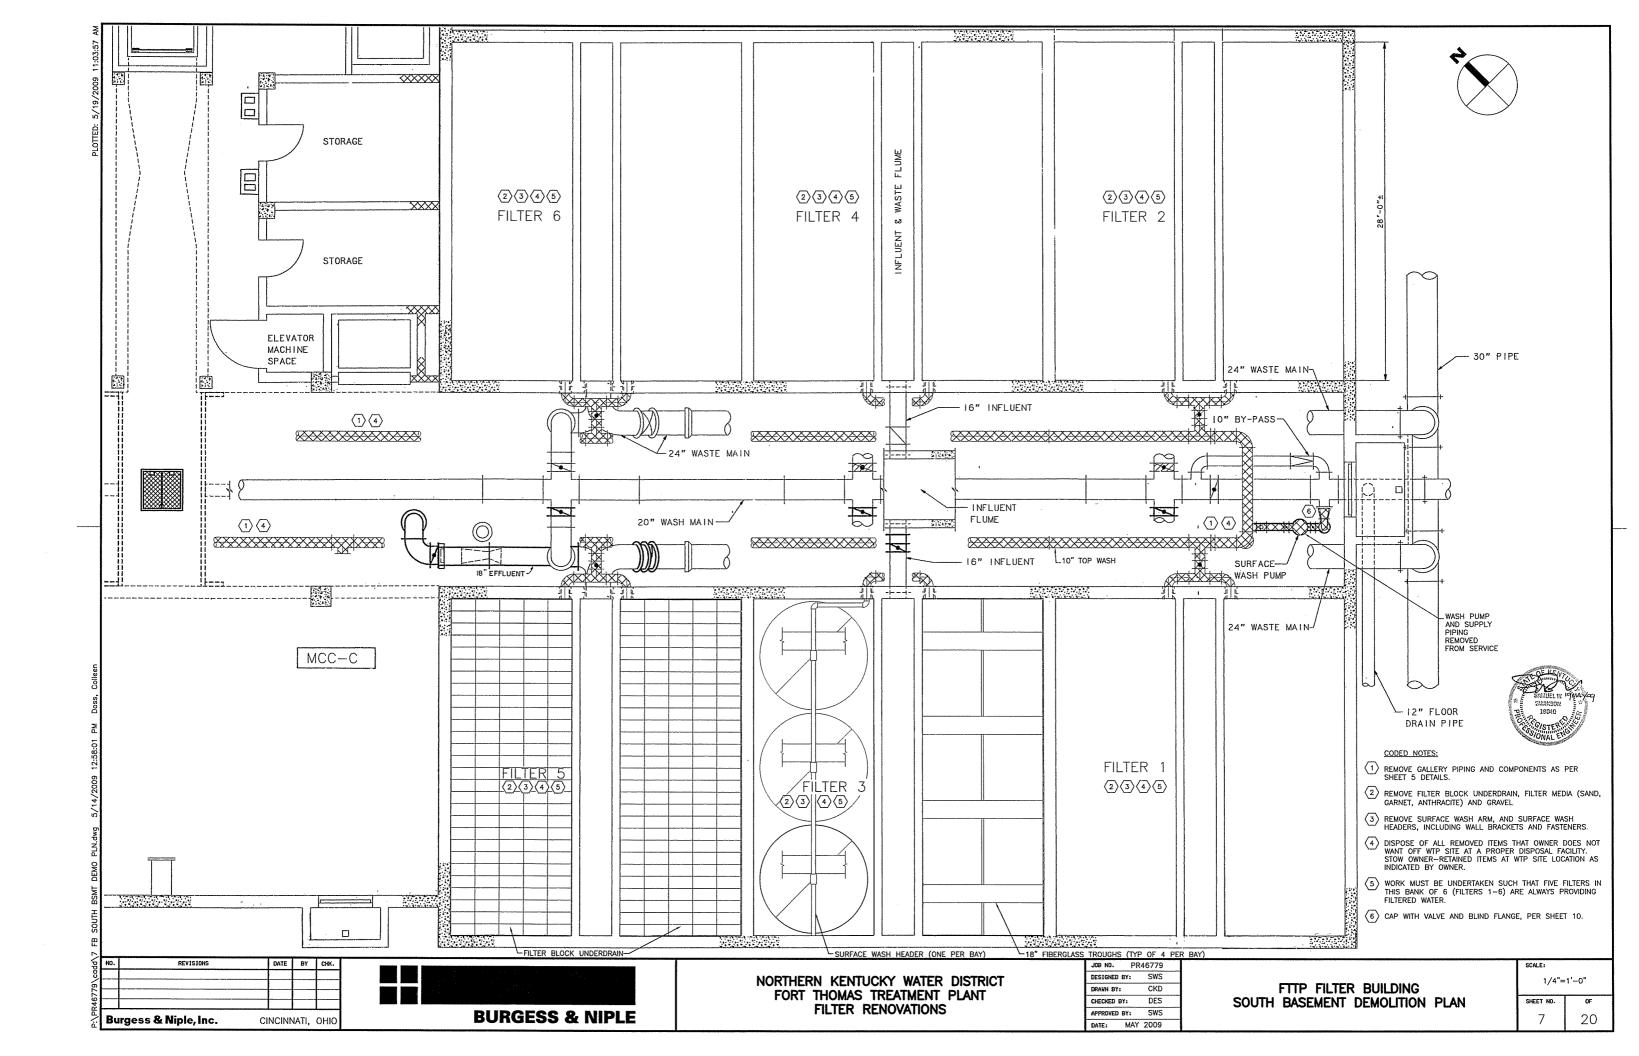
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NORTHERN KENTUCKY WATER DISTRICT FORT THOMAS TREATMENT PLANT FILTER RENOVATIONS

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DRAWN BY:	CKD	
CHECKED BY:	DES	
APPROVED BY:	SWS	
DATE: MAY	2000	

FFTP FILTER BUILDING **DEMOLITION SECTIONS**

1/4"=1'-0"

EXISTING FILTER UNDERDRAIN

SCALE: 1" = 1'-0"

CODED NOTES:

REPAIR VOIDS, CRACKS, AND OTHER DAMAGE TO CONCRETE SURFACE CAPPING FLOOR WITH NON-SHRINK GROUT, PER SPECIFICATIONS. TYPICAL OF 24 FILTER BAYS.

4"ø HEADER -(REMOVE) 3/8"ø U.BOLT (REMOVE) 1/2"Ø HEADER 2"ø RISER (REMOVE) SUPPORT (TYP. (REMOVE) -STABILIZER ANGLE W/SLOTTED HOLES (TYP.) SIZED BY MANUFACTURER (MAINTAIN) - 3/8"ø U.BOLT (REMOVE) 18"X18" FIBERGLASS TROUGH -(MAINTAIN)

> EXISTING BRACING FOR WASH TROUGH AND SURFACE WASH PIPE SCALE: 1" = 1'-0"

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NORTHERN KENTUCKY WATER DISTRICT FORT THOMAS TREATMENT PLANT FILTER RENOVATIONS

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APPROVED BY:	SWS	
DATE: MAY	2009	

FFTP FILTER BUILDING FILTER RENOVATION DETAILS

CALE:	
1"=1'-0"	
SHEET NO.	0F
9	20

5 PROVIDE FILTER BUILDING WALL PENETRATION PER DETAIL ON SHEET 15.



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Burgess & Niple, Inc.





NORTHERN KENTUCKY WATER DISTRICT FORT THOMAS TREATMENT PLANT FILTER RENOVATIONS


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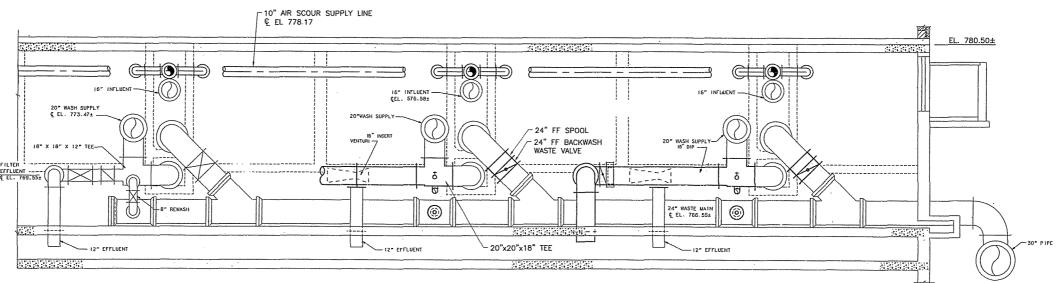
FFTP FILTER BUILDING PIPE GALLERY AIR PIPING PLAN

SCALE:	
1/8"=	1'-0"
SHEET NO.	0F



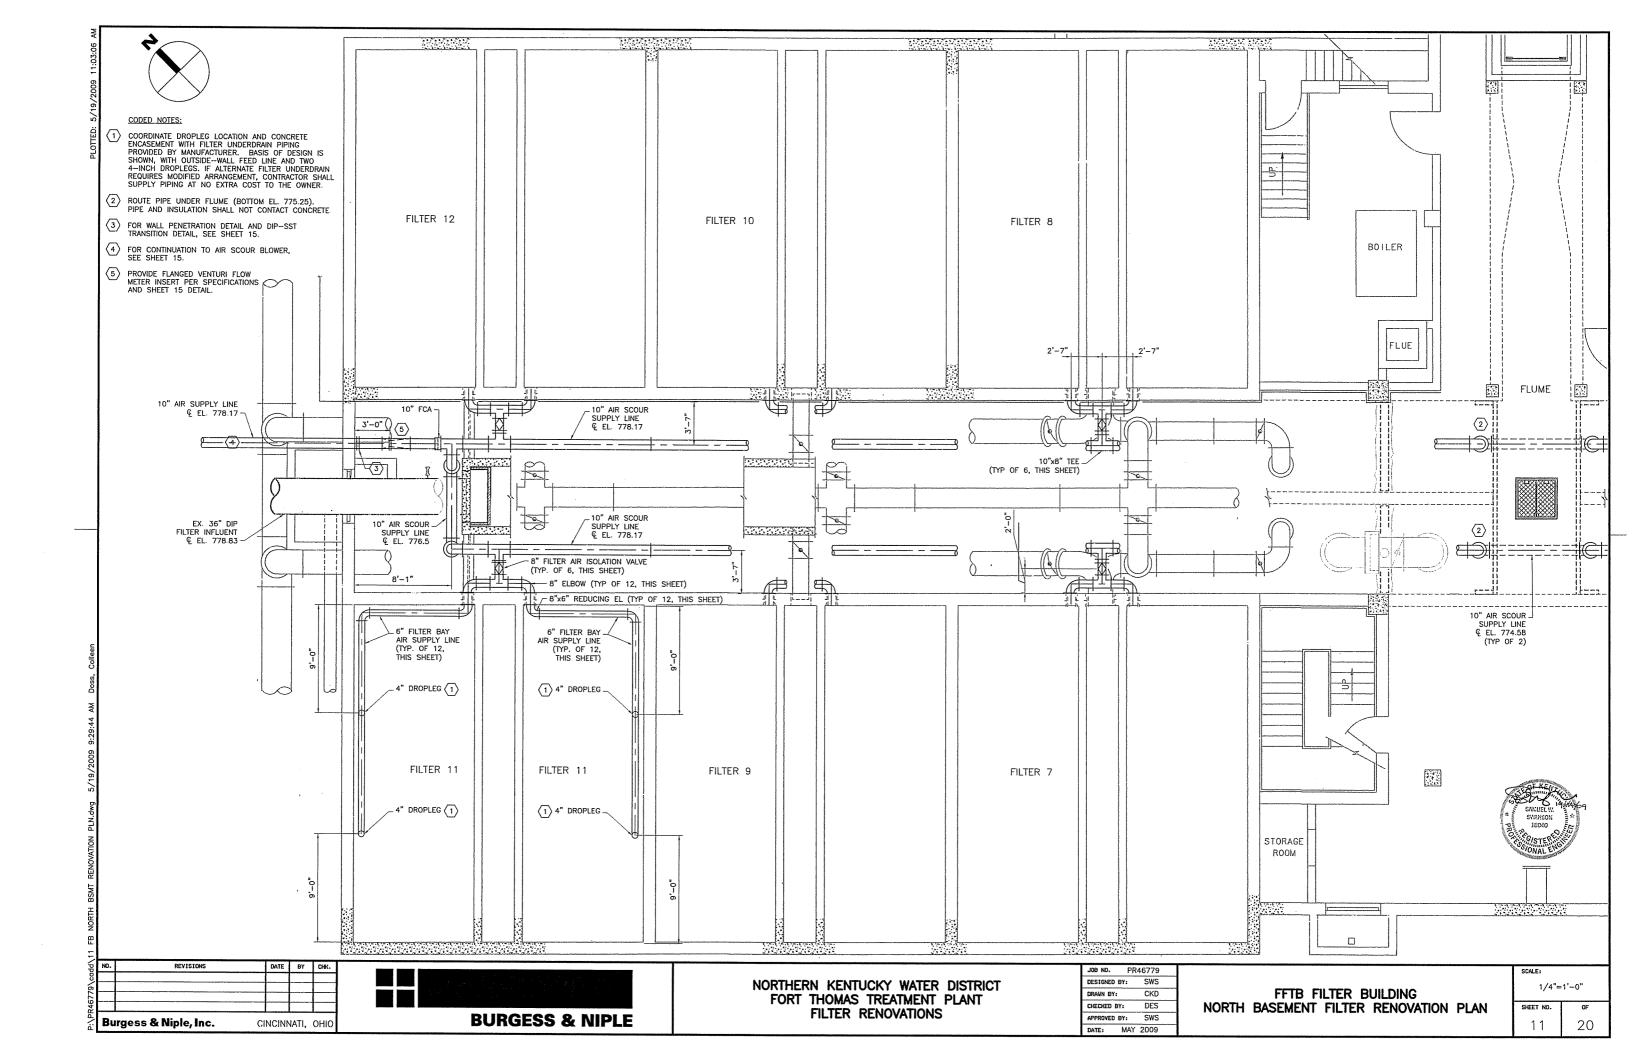

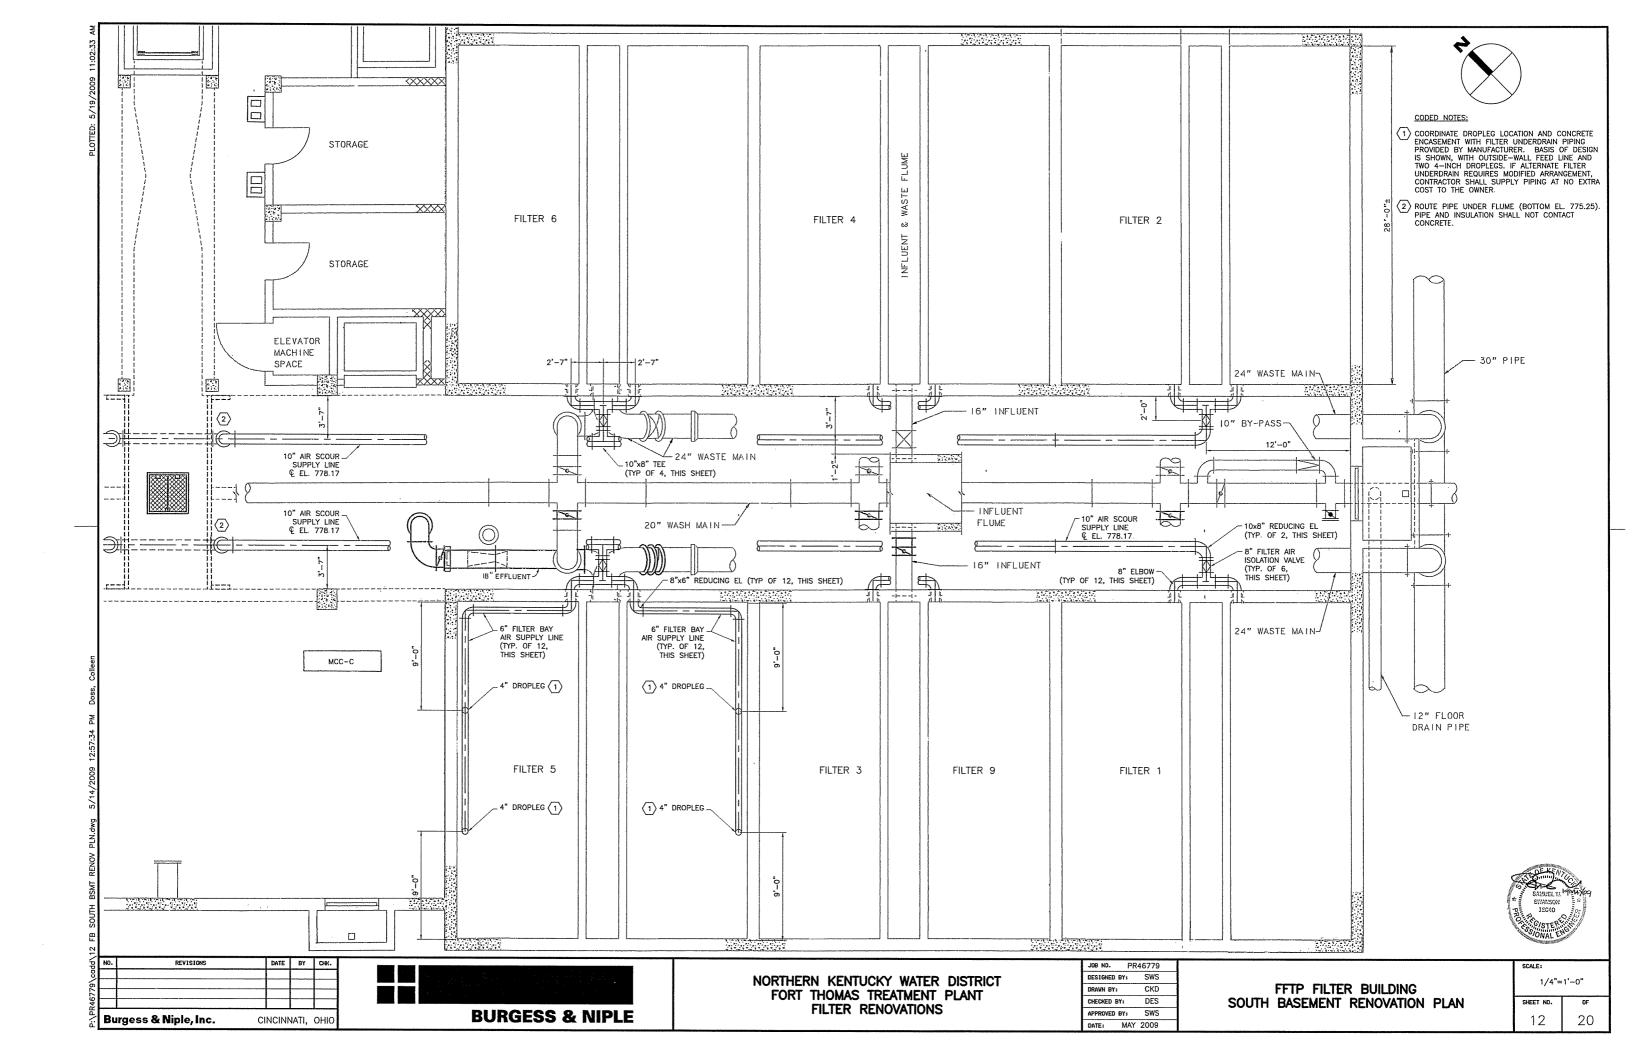

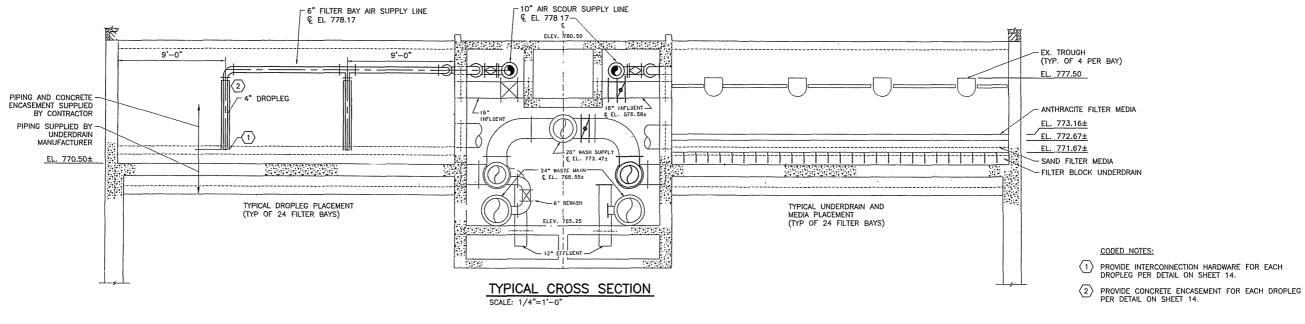

TYPICAL LENGTHWISE SECTION

SCALE: 1/4"=1'-0"



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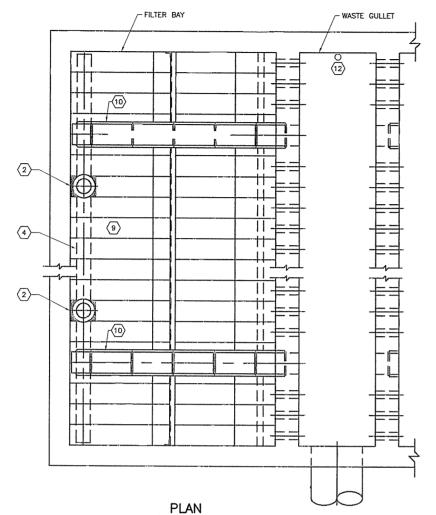


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FFTP FILTER BUILDING FILTER RENOVATION SECTIONS

5	CAL	E:	
		1/4"=1	1'-0"




SCALE: NONE

CODED NOTES:

- 1) PROVIDE ANCHOR RODS, AS REQUIRED BY UNDERDRAIN MANUFACTURER.
- (2) INSTALL CONCRETE 12"x12" COLUMN ENCASEMENT AFTER UNDERDRAIN AND AIR HEADER ARE INSTALLED. CONCRETE COLUMN BASE SHALL BE FLUSH WITH TOP OF UNDERDRAINS. DOWEL ENCASEMENT WITH #5 ON 12" CENTERS, WITH 3" OF DOWEL IN NEW CONCRETE AND 3" OF DOWEL IN EXISTING CONCRETE.
- SET UNDERDRAIN BLOCK ON 3/4" OF NEW NON-SHRINK GROUT, PLACED PER SPECIFICATIONS AND UNDERDRAIN MANUFACTURER'S REQUIREMENTS. USE HIGHEST FLOOR ELEVATION AS REFERENCE BASE.
- PROVIDE 4" AIR HEADER (SCHEDULE 5 WITH AIR RISER PIPES ON 12" CENTERS, TYPE 304 SST). PROVIDE WITH TYPE 316 SST CLIP ANGLES ANCHORED TO TANK WALL.
- 5 PROVIDE MAKE--UP BLOCK, PER FILTER UNDERDRAIN MANUFACTURER'S REQUIREMENTS.
- 6 PROVIDE 45' GROUT FILLET EXTENDING 1-2 INCHES INTO BLOCK (TYPICAL).
- $\overline{\mbox{\scriptsize 7}}$ PROVIDE FLUME BLOCK WITH WELDED END PLATE. CAULK BETWEEN WALL AND END PLATE.
- PROVIDE FILTER BLOCK CAP, PER SPECIFICATIONS AND FILTER UNDERDRAIN MANUFACTURER'S REQUIREMENTS.

 PROVIDE FILTER BLOCK, 27 EQUAL SPACES ON 12" CENTERS. PER FILTER UNDERDRAIN MANUFACTURER'S REQUIREMENTS.
- MAINTAIN FOUR EXISTING WASH WATER TROUGHS AND STABILIZER BARS.

- 11) INTERCONNECT PIPING AT FLANGED CONNECTION. FILTER UNDERDRAIN MANUFACTURER SHALL SUPPLY FULL NEOPRENE GASKET AND MINLON SLEEVES. INSTALLING CONTRACTOR SHALL PROVIDE MATING FLANGE AND TYPE 304 SST CONNECTION HARDWARE FOR 4" DROPLEGS.
- (12) PROVIDE 1" SCHEDULE 80 PVC FLUME AIR VENT PIPE WITH ORIFICED END CAP (TYPICAL OF 12). SUPPORT WITH TYPE 316 SST WALL-BRACKET HARDWARE.
- SECURE ANGLE WITH 3/8" WEDGE TYPE ANCHORS. CAULK BETWEEN ANGLE, WALL AND UNDERDRAIN, PER FILTER UNDERDRAIN MANUFACTURER'S REQUIREMENTS.
- SEAL BETWEEN ANGLE AND GROUT JOINT WITH CAULK, PER FILTER UNDERDRAIN MANUFACTURER'S REQUIREMENTS.
- 15) PROVIDE SHELF ANCHOR WITH 3/8" WEDGE TYPE ANCHORS, PER FILTER UNDERDRAIN MANUFACTURER'S REQUIREMENTS.

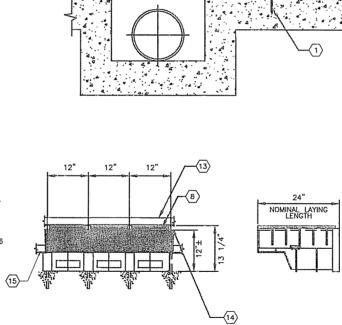


12

WASTE | GULLET

EL. 779.0



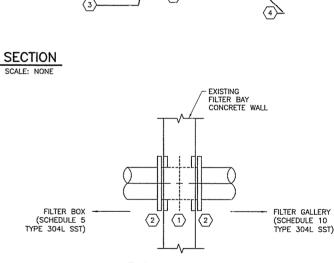

(11)

6

FILTER WALL
PENETRATION DETAIL
SCALE: NONE

DETAIL CODED NOTES:

(1) CLEAN EXISTING WALL PIPE OF ALL ACCUMULATED SCALE AND REMOVE LINING (PAINT AND CEMENT GROUT) TO BASE METAL

EL. 777.5

EL. 776.5

(2) ISOLATE NEW SST AIR PIPE WITH INSULATING FLANGES SUITABLE FOR HIGH-TEMPERATURE AIR SERVICE AND SST CONNECTION HARDWARE WITH SLEEVES TO AVOID CONTACT OF DISSIMILAR METALS.



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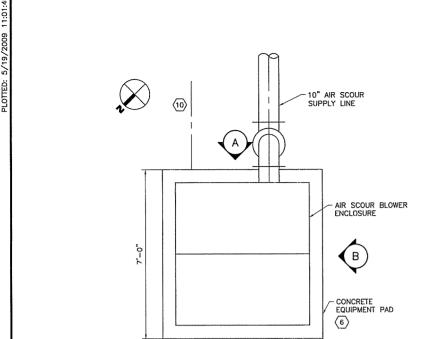
NORTHERN KENTUCKY WATER DISTRICT FORT THOMAS TREATMENT PLANT FILTER RENOVATIONS


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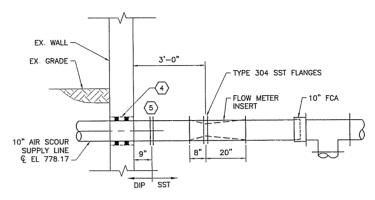
FILTER BAY


FFTP FILTER BUILDING
FILTER BOX RENOVATION DETAILS

SCALE:	
NO	NE
SHEET NO.	OF





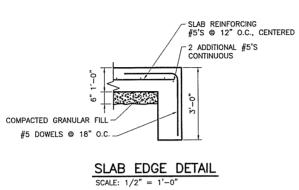

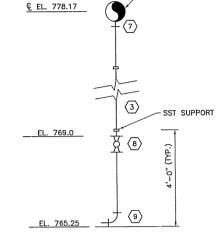


-10" AIR SCOUR LINE

CONDENSATE
BLOWOFF DETAIL
SCALE: NONE

BLOWER PLAN
SCALE: 1/2" = 1'-0"


6'-8"

FILTER BUILDING
WALL PENETRATION DETAIL

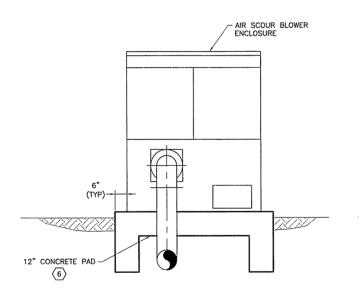

ELEVATION

SCALE: 1/2" = 1'-0"

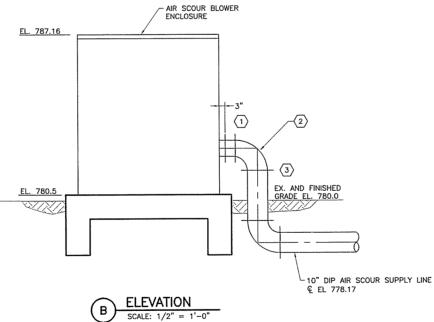

CODED NOTES:

- (1) INTERCONNECT BLOWER DISCHARGE PLAIN END (3" FROM BLOWER ENCLOSURE) WITH PIPING PLAIN END USING RUBBER BOOT AND CLAMPS PROVIDED BY BLOWER MANUFACTURER.
- 2 PROVIDE FLANGED 10"x8" REDUCING ELBOW.
- (3) INSULATE EXPOSED AIR PIPING.
- CORE DRILL WALL TO CLEAR PIPE AND LINK SEAL.
 PROVIDE DOUBLE LINK SEAL INSET 2" FROM WALL
 FACE AND COMPATIBLE WITH HIGH-TEMPERATURE
 SERVICE. SEAL ANNULAR SPACE ON EACH SIDE
 OF PIPE PENETRATION WITH NON-SHRINK GROUT,
 PER SPECIFICATIONS.
- (5) PROVIDE ISOLATING GASKET AND FASTENER COMPONENTS TO PREVENT CONTACT OF DISSIMILAR METALS FOR BOTH PIPE MATERIALS AND CONNECTION HARDWARE MATERIALS.
- PROVIDE PAD WITH THICKENED EDGE PER DETAIL THIS SHEET.
- 7 PROVIDE 1/2" TYPE 304 SST CORPORATION STOP, 1/2" PIPING AND WALL-MOUNTING CONNECTION HARDWARE.
- (B) PROVIDE TYPE 304 SST BALL VALVE SUITABLE FOR AIR SERVICE.
- 9) ROUTE PIPE TO FLOOR/WALL INTERSECTION AND DIRECT PIPE DISCHARGE ALONG WALL.
- (10) INTERCONNECT BLOWER AND POWER AND CONTROL CABLES PER BLOWER MANUFACTURER'S RECOMMENDATIONS AND INSTALLATION REQUIREMENTS.



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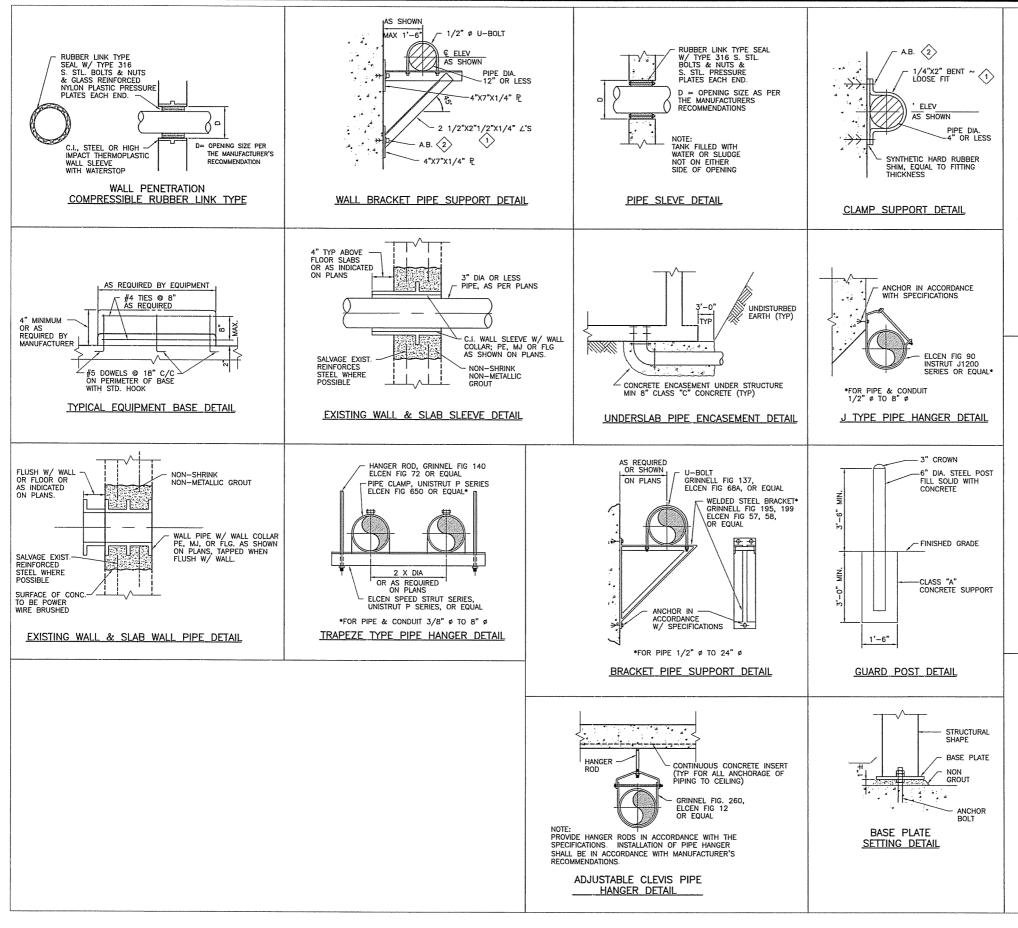



NORTHERN KENTUCKY WATER DISTRICT FORT THOMAS TREATMENT PLANT FILTER RENOVATIONS

JOB NO. PR	46779
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DATE: MAY	2009

FFTP FILTER BUILDING AIR SCOUR BLOWER DETAILS


SCALE:		
1/2"=	=1'-0"	
SHEET NO.	OF	
15	20	



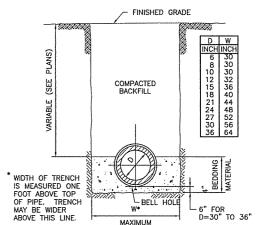

TYPE 1 BEDDING SHALL BE USED FOR ALL ROADWAY AND PARKING AREAS WITH COMPACTED GRANULAR FILL USED UP TO AGGREGATE FOR PAVEMENT.

TYPE I BEDDING DETAIL

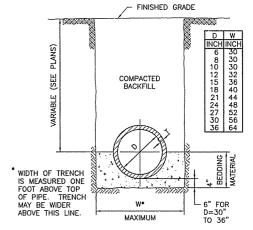

TYPE II BEDDING DETAIL

GENERAL NOTES FOR PIPING INSIDE STRUCTURES

- 1. ALL FLANGED PIPING UNLESS NOTED OTHERWISE SHALL BE DUCTILE IRON (DIP).
- PIPING WITH COUPLINGS OR MECHANICAL JOINTS SHALL BE ADEQUATELY RESTRAINED, TIED OR BLOCKED, TO PREVENT MOVEMENT UNDER TEST AND OPERATING PRESSURES. THE REQUIRED TIES AND BLOCKING ARE NOT SHOWN.
- 3. SLEEVE COUPLINGS AND COUPLING ADAPTERS FOR DUCTILE IRON PIPING SHALL BE CAST IRON AS MANUFACTURED BY DRESSER, SMITH BLAIR OR EQUAL.
- 4. PIPING SHALL BE ADEQUATELY SUPPORTED. THE REQUIRED PIPE HANGERS AND SUPPORTS ARE NOT ALL SHOWN. PIPE HANGERS AND PIPE SUPPORTS SHALL BE AS SHOWN ON THIS SHEET AND AS SPECIFIED.
- IF CONCRETE SUPPORTS ARE SHOWN, SEE MISCELLANEOUS CONCRETE DETAILS SHEET FOR TYPICAL CONCRETE PIPE SUPPORTS. PROVIDE HANGER OR SUPPORT AT ALL FITTINGS AND AT A MAXIMUM SPACING OF 8'-O" ON STRAIGHT PIPE.
- 6. DIELECTRIC FITTINGS SHALL BE PROVIDED WHERE PIPES OF DISSIMILAR METALS MEET.



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NORTHERN KENTUCKY WATER DISTRICT FORT THOMAS TREATMENT PLANT FILTER RENOVATIONS

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APPROVED BY:	SWS	1
DATE: MAY	2009	1

PROCESS MECHANICAL DETAILS

SCALE:		
NONE		
SHEET NO.	0F	
16	20	

(5) RELOCATE EXISTING PANEL ONTO BACK SIDE OF MCC. SEE SHEET 18.

 $\stackrel{\textstyle \longleftarrow}{6}$ disconnect existing isolation valve. Preserve and protect conduit and conductors for reuse.

 $\fbox{7}$ relocate temporarily existing two air conditioning units, as directed by the owner.



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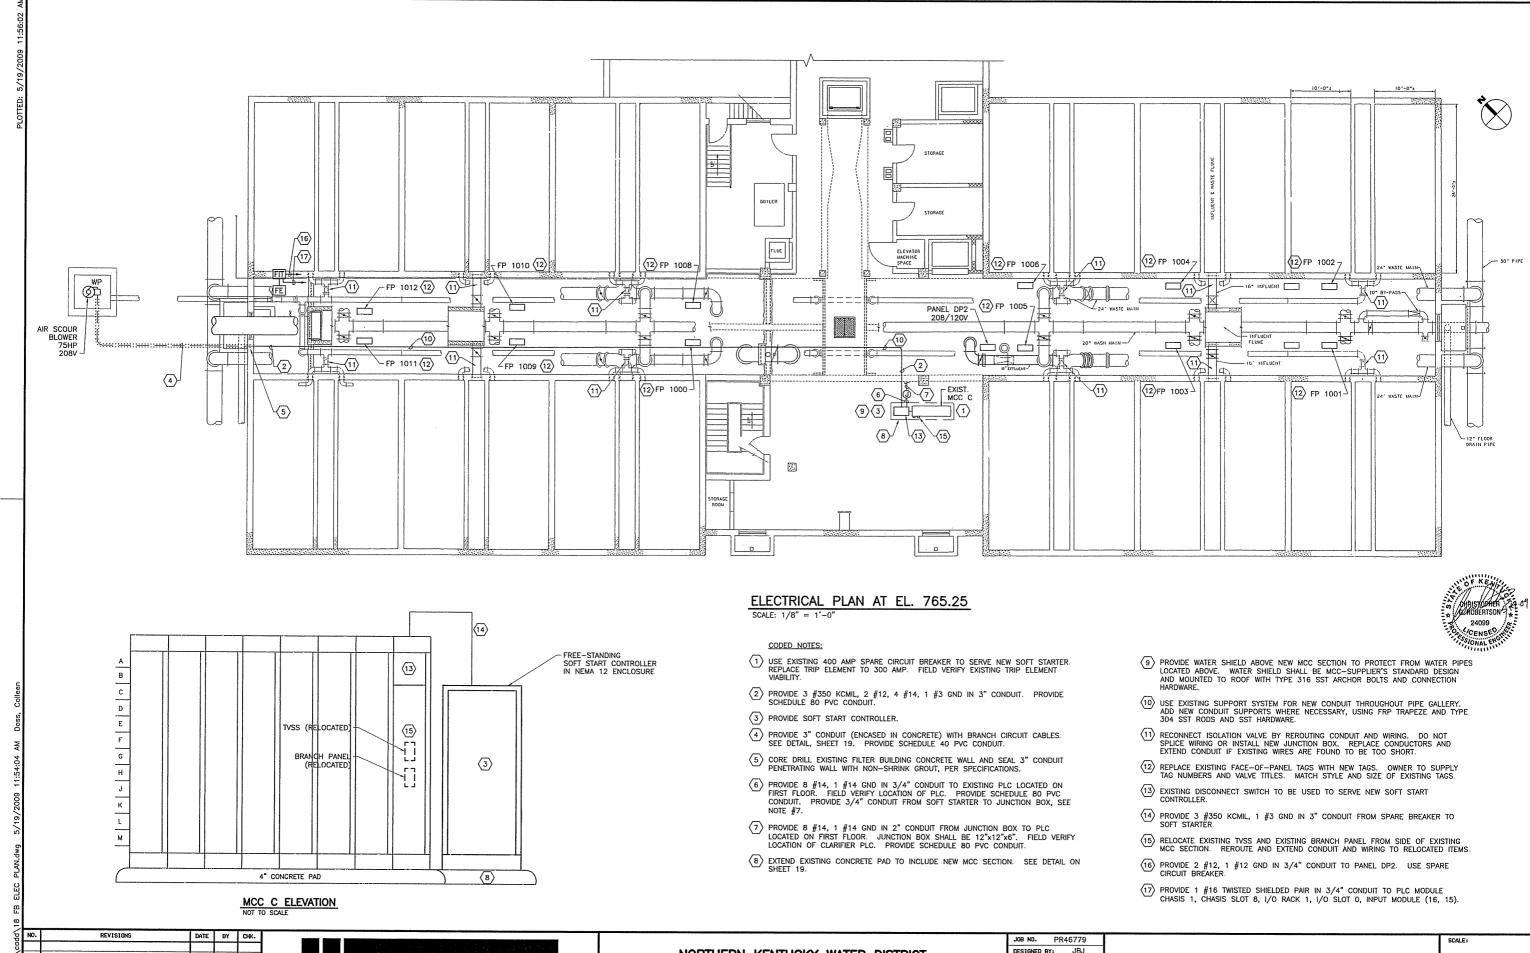


NORTHERN KENTUCKY WATER DISTRICT FORT THOMAS TREATMENT PLANT FILTER RENOVATIONS

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	APPROVED BY:	SWS	1
	DATE: MAY	2009	1

FTTP FILTER BUILDING PIPE GALLERY ELECTRICAL DEMOLITION PLAN

SCALE:	
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SHEET NO.	OF
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NORTHERN KENTUCKY WATER DISTRICT FORT THOMAS TREATMENT PLANT FILTER RENOVATIONS

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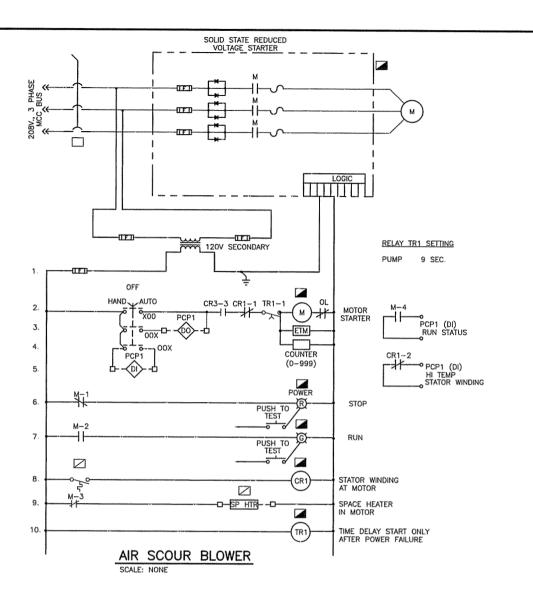
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CHECKED BY: CR
APPROVED BY: SWS
DATE: MAY 2009

FTTP FILTER BUILDING
PIPE GALLERY ELECTRICAL PLAN

AS NOTED

SHEET NO. OF

18 20



CONDUIT/WIRING		
	EXPOSED CONDUIT	
	UNDERGROUND CONDUIT ENCASED IN CONCRETE	
	CONDUIT IN SLAB	
	CONCEALED CONDUIT	
LPLS-1	HOMERUN - TO PANEL LPLS, CIRCUIT NO. 1	
A-1,3	TWO SINGLE POLE CIRCUITS	
A(1,3)	ONE TWO POLE CIRCUIT	
A(1,3,5)	ONE THREE POLE CIRCUIT	
	UNDERGROUND DUCT BANK ENCASED IN CONCRETE	

NOTE: THIS IS A STANDARD LEGEND, SOME SYMBOLS OR ABBREVIATIONS MAY APPEAR ON THIS SHEET AND NOT ON THE PLANS.

CONTROL DIAGRAM LEGEND		
DEVICE LOCATED IN MCC		
DEVICE LOCATED IN FIELD DEVICE LOCATED IN MOTOR CONTROLLER PROGRAMMABLE CONTROL PANEL DI — DISCRETE INPUT DO — DISCRETE OUTPUT		

MISCELLANEOUS POWER		
	PLYWOOD BACKBOARD FIRE TREATE REFER TO PLANS FOR SIZE	
	FLUSH MOUNTED PANELBOARD	
	SURFACE MOUNTED PANELBOARD	
	FLUSH MOUNTED EQUIPMENT	
	SURFACE MOUNTED EQUIPMENT	
	NON-FUSIBLE DISCONNECT SWITCH	
Ø	FUSIBLE DISCONNECT SWITCH	
Ø	THREE PHASE MOTOR	
N/	SINGLE PHASE MOTOR	
\boxtimes_1	COMBINATION TYPE STARTER WITH FUSIBLE DISC. SWITCH	
•	PUSHBUTTON	
3	JUNCTION BOX	
FE	FLOW METER ELEMENT	
FIT	FLOW TRANSMITTER AND INDICATOR	

DIAGRAM_SYMBOLS		
->	FUSED DISCONNECT SWITCH SIZE AS INDICATED ON PLANS	
^	NON-FUSED DISCONNECT SWITCH SIZE AS INDICATED ON PLANS	
-^-	CIRCUIT BREAKER SIZE AS INDICATED ON PLAN	
-0-0-	TRANSFER SWITCH SIZE AS INDICATED ON PLANS	
*	POTENTIAL TRANSFORMER	
3	CURRENT TRANSFORMER	
8	METER: X INDICATES TYPE V = VOLTMETER A = AMMETER	
xx	CONTROLLER: X INDICATES TYPE AF = ADJUSTABLE FREQ. DRIVE 2 = TWO SPEED ONE WINDING NR = FULL VOLT. NON REVERS. R = FULL VOLTAGE REVERS.	
***	TRANSFORMER	
Ţ	EARTH GROUND	
×	MOTOR LOAD 'X' INDICATES HP, AMPS., OR KW	
×	GENERAL LOAD 'X' INDICATES HP, AMPS., OR KW	
X	LOCAL COMBINATION STARTER X = SIZE Y DESCRIPTION	
X	LOCAL MANUAL STARTER X = SIZE Y DESCRIPTION	
X	LOCAL FUSED DISCONNECT SWITCH X = SIZE Y DESCRIPTION	
X	NON-FUSED DISCONNECT SWITCH X = SIZE Y DESCRIPTION	
REMOTE PUSHBUTTON STATION X = NUMBER OF DEVICES		


CON	ROL DIAGRAM SYMBOLS
OPEN ON CLOSE ON INCREASE	PRESSURE SWITCH
-020-020	LEVEL SWITCH
~ La ~ Lo	FLOW SWITCH
~ 5 ~ 6 ~	TEMPERATURE SWITCH
NORMALLY NORMALLY CLOSED OPEN	PUSH BUTTON
NORMALLY NORMALLY CLOSED OPEN	INSTANTANEOUS CONTACT
-010 -050	TIMED CLOSE CONTACT
-010-00	TIMED OPEN CONTACT
-020 -000	LIMIT SWITCH
ō ōox	SELECTOR SWITCH:QUANTITY OF ARROWS INDICATES NUMBER OF POSITIONS XO INDICATES UPPER CONTACT CLOSED IN LEFT POSITION AND OPEN IN RIGHT POSITION
-M +PL	STARTER COIL AND OVERLOAD
CR	RELAY COIL
≫	PILOT LIGHT 'X' INDICATES COLOR : R=RED, G=GREEN, A=AMBER, B=BLUE, W=WHITE, Y=YELLOW
H	HORN
O B	BELL
010	SOLENOID
+	NO JUNCTION
+	JUNCTION
0	TERMINAL
	I

DEMOLITION NOTES

- EXISTING DEVICES THAT ARE RECONNECTED TO NEW PANELS SHALL BE TESTED FOR PROPER OPERATION. ANY DEVICES NOT IN WORKING CONDITION SHALL BE REPORTED TO OWNER'S PROJECT REPRESENTATIVE IMMEDIATELY.
- 2. ELECTRICAL CONTRACTOR SHALL VISIT THE JOB SITE TO REVIEW THE EXTENT OF DEMOLITION WORK AND COUNTING THE DEVICES BEFORE SUBMITTING THE BIDS. NO EXTRA ALLOWANCE SHALL BE PERMITTED DURING CONSTRUCTION.
- 3. THIS CONTRACTOR SHALL REFER TO ALL PROCESS DRAWINGS FOR LOCATIONS OF EQUIPMENT TO BE REMOVED BY THE PROCESS CONTRACTOR. THE ELECTRICAL CONTRACTOR SHALL DISCONNECT WIRING FROM ABANDONED EQUIPMENT AND PULL WIRING BACK TO SOURCE. REMOVED ALL EXPOSED CONDUITS, AND IF CONDUIT IS UNDER SLAB, CUT CONDUIT OFF AT FLOOR AND PATCH FLOOR.
- 4. ELECTRICAL CONTRACTOR SHALL REFER TO PROCES DRAWINGS FOR DEMOLITION WORK AND SHALL DISCONNECT, RELOCATE ELECTRICAL EQUIPMENT AND CONDUIT AND WIRING AS REQUIRED.
- 5. CONTRACTOR SHALL REROUTE AND RECONNECT ANY CIRCUITS THAT WILL REMAIN IN USE BUT INTERFERE WITH NEW CONSTRUCTION.
- 6. ALL EXISTING CONDUITS THAT WILL NOT BE REUSED SHALL BE REMOVED WHERE THEY WILL BE EXPOSED AFTER COMPLETION OF CONSTRUCTION. ALL OTHERS MAY BE ABANDONED IN CELING OR BELOW FLOOR. CONTRACTOR SHALL REMOVE ALL WIRING FROM ABANDONED CONDUITS, DISCONNECT FROM ALL POWER SOURCES.
- PROTECT EXISTING WORK, WHICH IS TO REMAIN IN PLACE, BE REUSED, OR REMAIN THE PROPERTY OF THE OWNER. REPAIR ITEMS THAT ARE TO REMAIN AND WHICH ARE DAMAGED DURING PERFORMANCES OF THE WORK TO THEIR ORIGINAL CONDITION, OR REPLACE WITH NEW.

GENERAL NOTES: (APPLIES TO ALL DRAWINGS)

- 1. UNLESS INDICATED ALL WIRING SHALL BE CONSIDERED #12, 1#12 GND IN 3/4" CONDUIT.
- 2. UNLESS INDICATED, ALL MOUNTING ELEVATIONS ARE BOTTOM ELEVATIONS OF DEVICE.
- 3. CONSOLIDATION OF INDIVIDUAL CONDUIT HOME RUNS SHOWN ON THE DRAWINGS SHALL NOT BE PERMITTED WITHOUT PRIOR WRITTEN APPROVAL BY THE ENGINEER.
- 4. UNLESS INDICATED ON DRAWINGS, PROVIDE SEPARATE NEUTRAL FOR ALL CIRCUITS.
- 5. WHERE NEW FEEDERS ARE INDICATED TO BE RUN FROM NEW PANEL BOARDS OR CONTROL CENTERS TO HVAC EQUIPMENT, THIS CONTRACTOR SHALL FIELD VERIFY THE EXACT CONTROL WIRING REQUIRED FOR EACH MOTOR AND PROVIDE WIRING AS REQUIRED.
- 6. THE LIST OF EQUIPMENT, TABULATIONS OF DATA, AND SCHEDULES APPEARING ON THE DRAWINGS ARE INCLUDED ONLY FOR THE ASSISTANCE AND GUIDANCE OF THE CONTRACTOR IN ARRIVING AT A MORE COMPLETE UNDERSTANDING OF THE INTENDED INSTALLATION. THEY ARE NOT INTENDED, NOR TO BE CONSTRUED, AS RELIEVING THE RESPONSIBILITY OF THE CONTRACTOR IN MAKING HIS OWN TAKEOFF AND PROVIDING ALL REQUIRED WORK.
- 7. THIS CONTRACTOR SHALL PROVIDE GROUNDING BUSHINGS FOR ALL CONDUITS. REFER TO SPECIFICATIONS FOR ADDITIONAL INFORMATION.
- 8. ALL CONDUIT AND SUPPORTS ABOVE GROUND SHALL BE PVC SCHEDULE 80.
- 9. SCREEN LINES INDICATE EXISTING WORK TO REMAIN. HEAVY LINES INDICATE NEW WORK.

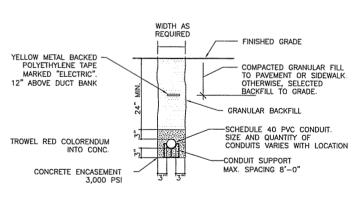

UNDERGROUND DUCT BANK DETAIL

	2"	Christopers 7- 24099 CENSE VONAL ENTER
L	EQUIPMENT	//4 TITO O O'
K.		#4 TIES @ 8"
	<u> </u>	HOUSEKEEPING PAD
	0.000.000.000	FINISHED FLOOR
	CONTRACTOR SERVICES	F34 1 13 13 13 13 13 13 13 13 13 13 13 13 1
NC		
	SLEEVE (WHERE REQUIRED) /	
	FILL WITH GROUT /	#5 DOWELS @ 18" C/C ON PERIMETER OF BASE
	ANCHOR BOLTS-SIZE AND LOCATION -	ON PERIMETER OF BASE WITH ADHESIVE ANCHOR.
	DEPEND UPON EQUIPMENT FURNISHED	HILTI OR EQUAL.

ELECTRICAL EQUIPMENT PAD NOT TO SCALE

NO.	REVISIONS	 DATE	BY	снк.
		 		-



NORTHERN KENTUCKY WATER DISTRICT FORT THOMAS TREATMENT PLANT FILTER RENOVATIONS

708 NO B	R46779
DESIGNED BY:	JBJ
DRAWN BY:	CKD
CHECKED BY:	CR
APPROVED BY:	SWS
DATE: MAY	2009

ELECTRICAL NOTES, SYMBOLS AND DETAILS

SCALE:	
NONE	
SHEET NO.	0F
19	20

